


*Playground Supervision Required

PLAYWORLD™

© 2007 Playworld Systems, Inc.
Playworld™ is a brand of Playworld Systems, Inc.



PROJECT NO: 238-0923	REV: a	DATE: 14-DEC-09
SYSTEM: EXPLORERS	SCALE: NOT TO SCALE	
SITE PLAN	DRAWN BY: CHIP ZECHMAN	

Playworld Systems, Inc.
1000 Buffalo Road
Lewisburg, PA
17837-9795 USA


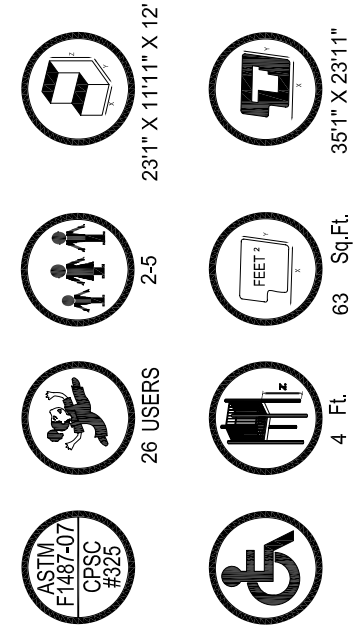


238-0923

2010 CATALOG

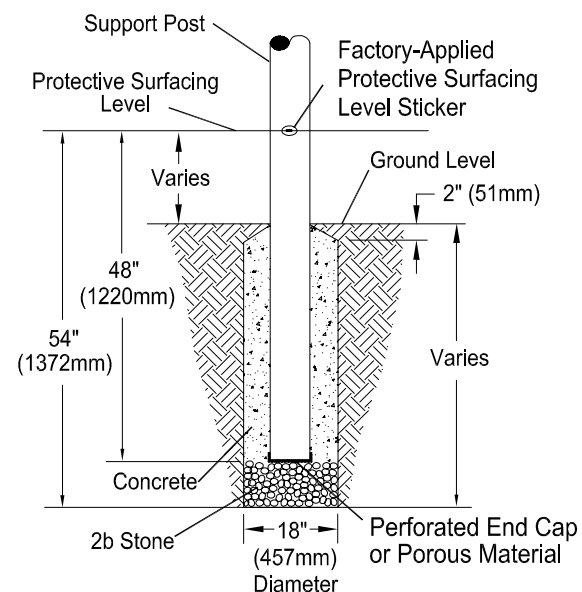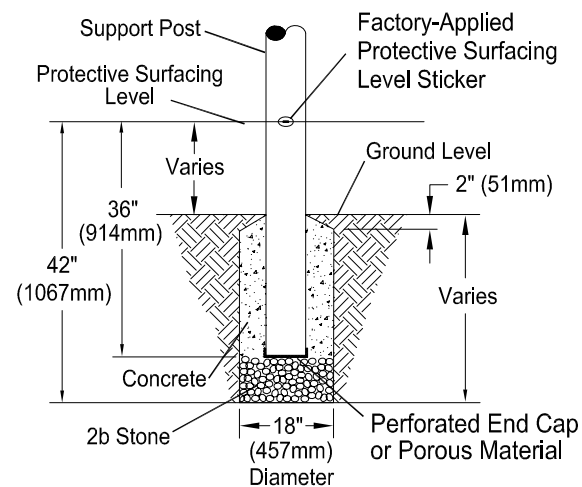

- ### INSTALLATION NOTES:
- 1) Paved surfaces, such as asphalt and concrete, are not acceptable for use under your structure.
 - 2) It is the consumer's responsibility to check with local utilities prior to excavating footings for any underground utility lines that may exist within the installation area.
 - 3) It is the consumer's responsibility to check local soil conditions and drainage within the site area. Inquire with local contractors for appropriate recommendations.
 - 4) If the structure is to be installed across uneven terrain, maintain the support post mark for protective surfacing level at the lowest grade. Adjust other footings accordingly.
 - 5) The base of footings must be below frost lines.
 - 6) Do not encase the bottom of support posts in concrete. Place all posts directly on packed stone.
 - 7) Assemble the entire structure before pouring concrete unless specifically instructed to do so in the individual component installation instructions.
 - 8) Read completely the installation instructions provided with your structure prior to beginning construction.

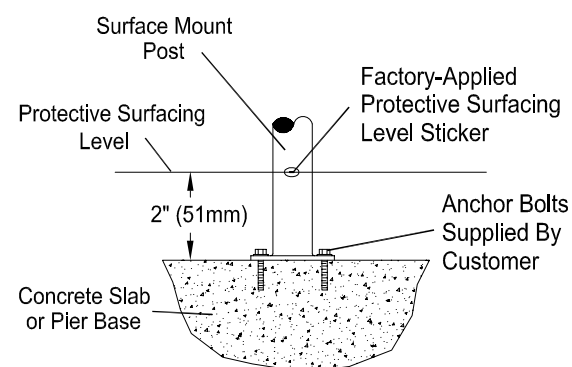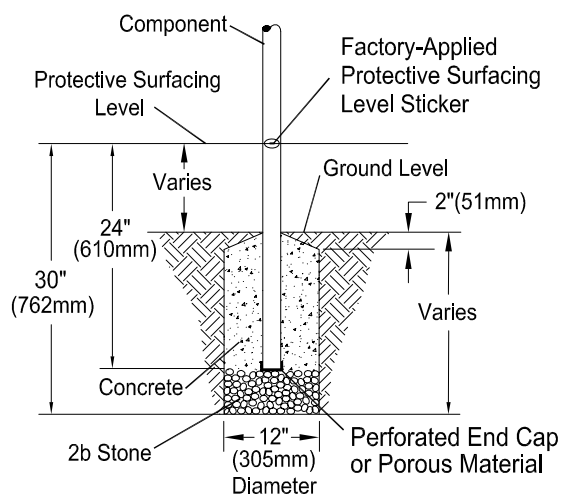

- ### SITE NOTES:
- 1) The site plan provided must be checked against the actual site area to ensure that placement of your structure meets required clearances.
 - 2) The dimensions labeled are for location of footing holes, not exact placement of equipment. Assemble, plumb, and level equipment before pouring concrete.
 - 3) There must be a minimum distance of 6' (1830mm) between any obstacle, sidewalk, etc., and your structure.
 - 4) Slides must have a use zone that extends out from the lower exit section of the slide a distance that is at least 6' (1830mm) or equal to the vertical distance from the highest point of the sliding surface to the top of the protective surfacing, whichever is greater. The slide use zone should not extend greater than 8' (2438mm) from the end of the lower exit section.
 - 5) The complete area, including the space under and around the equipment, must be covered with an impact attenuating material. See the 1997 publication, "Handbook for Public Playground Safety", published by the U.S. Consumer Product Safety Commission, for guidelines and recommendations on the type and depth of surfacing material. For a copy of the "Handbook for Public Playground Safety", write to:
**U.S. Consumer Product Safety Commission
Office of Information and Public Affairs
Washington, D.C. 20207**
 - 6) Supervise children as they play.

PROJECT NO: -----		REV: --	DATE: 05-OCT-07
FOOTING DETAIL		SCALE: NOT TO SCALE	
		DRAWN BY: TECH SALES	


Playworld Systems, Inc.
1000 Buffalo Road
Lewisburg, PA
17837-9795 USA

POST FOOTING DETAILS

PLAYMAKERS / CHALLENGERS

*Playground Supervision Required

*Playground Supervision Required

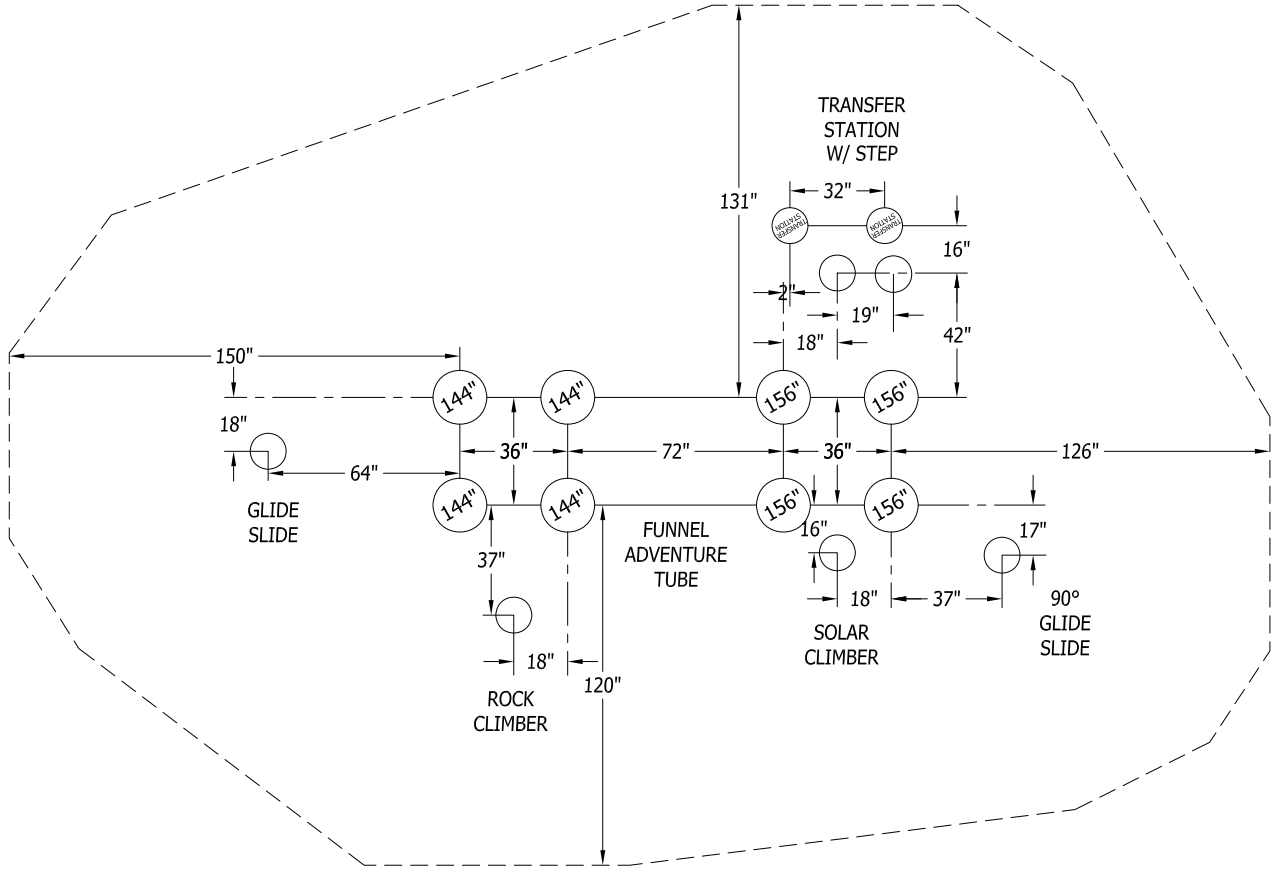


PLAYWORLD™


© 2007 Playworld Systems, Inc.
Playworld™ is a brand of Playworld Systems®, Inc.


PROJECT NO: 238-0923	REV: A	DATE: 14-DEC-09
SYSTEM: EXPLORERS		SCALE: 3/16" = 1'-0"
FOOTING PLAN		DRAWN BY: CHIP ZECHMAN


Playworld Systems, Inc.
1000 Buffalo Road
Lewisburg, PA
17837-9795 USA


FOOTING LEGEND

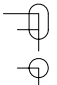= COMPONENT FOOTING (DETAIL 3)

= SPIRAL SLIDE CENTER POST FOOTING (DETAIL 1)

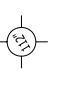= SUPPORT POST FOOTING (DETAIL 1 or 4)
(112" INDICATES POST LENGTH)

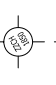= CANTILEVER 1"1" POST AND COMPONENT POST FOOTING (DETAIL 2)
(ZZCH1850 INDICATES PART NUMBER)

= GROUND ZERO POST FOOTING (DETAIL 2)
(144" INDICATES POST LENGTH)

238-0923

2010 Catalog